

General Notes:

- 1. THE BUILDER SHALL REVIEW ALL DRAWINGS THOROUGHLY BEFORE COMMENCING WORK AND NOTIFY THE DESIGNER OF ANY DISCREPANCIES WITHING 24" HOURS
- 2. ALL WORK SHALL MEET REQUIREMENTS OF MASSACHUSETTS STATE BUILDING CODE.

BUXTON LLOYD SHIPPY + ASSOCIATES

Architectural Designers and Planners

168 Mill Street Winchendon, MA 01475 Tel: 978.297.5033

Richard A. Smith PE Structural Engineer

Reading, MA 01867 Tel: 781.944.4151 email: rasmithPE@verizon.net




Project For:


ANTHONY SERETAKIS Proposed Rear Decks 197 College Avenue Somerville, MA 02114

Drawing Title:

DECK SECTION, LANDING PLAN & FOOTING & FRAMING DETAILS

Job No.		Revision:
Date Issued	10-5-17	
Scale	As Noted	Sheet Number:
Drawn By	BLS	
Approved By	BLS	
Phase: Workin	g Drawings	AJ.U

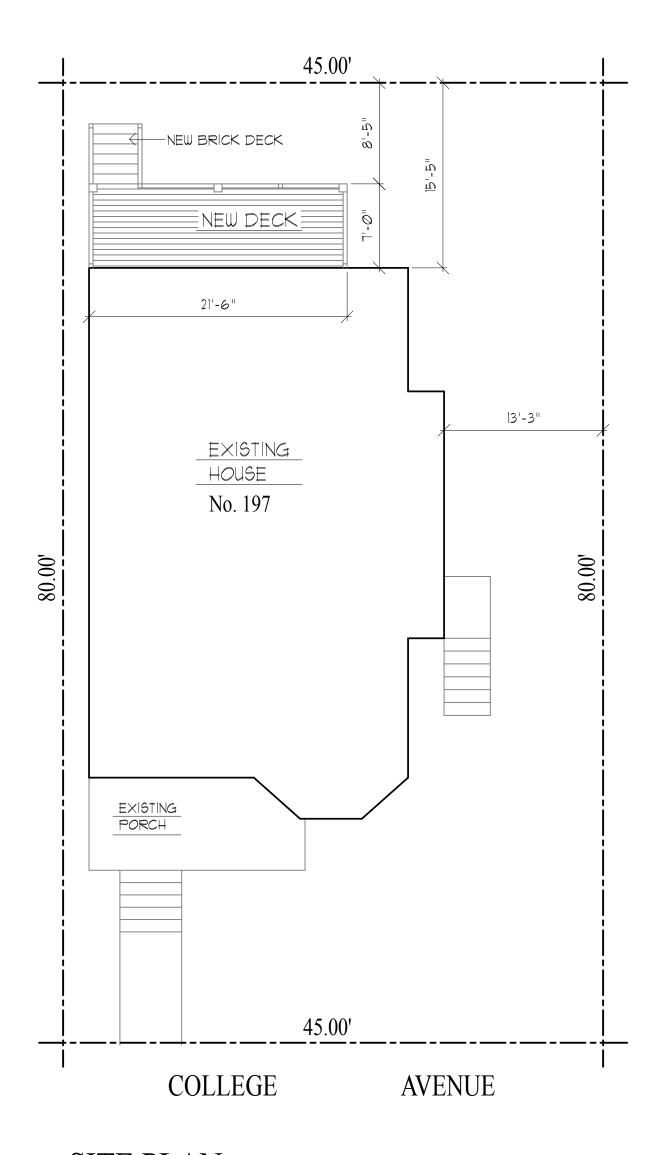

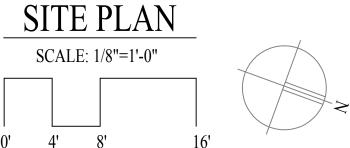

Project For:

ANTHONY SERETAKIS

Proposed Rear Decks 197 College Avenue Somerville, MA 02114 October 5, 2017

List Of Drawings:

COVER SHEET & SITE PLAN

- PROPOSED FIRST, SECOND & THIRD FLOOR DECK PLANS
- PROPOSED DECK ELEVATIONS
- PROPOSED FOOTING PLAN & DETAILS
- PROPOSED DECK FRAMING & HEADER FRAMING PLANS
- A5.0 PROPOSED DECK FRAMING SECTION & FRAMING DETAILS

BUXTON LLOYD SHIPPY + ASSOCIATES


Architectural Designers and Planners


168 Mill Street Winchendon, MA 01475 Tel: 978.297.5033 Email: buxton.shippy@verizon.net

Richard A. Smith PE Structural Engineer

Reading, MA 01867 Tel: 781.944.4151 email: rasmithPE@verizon.net

October 5, 2017

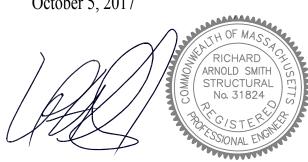

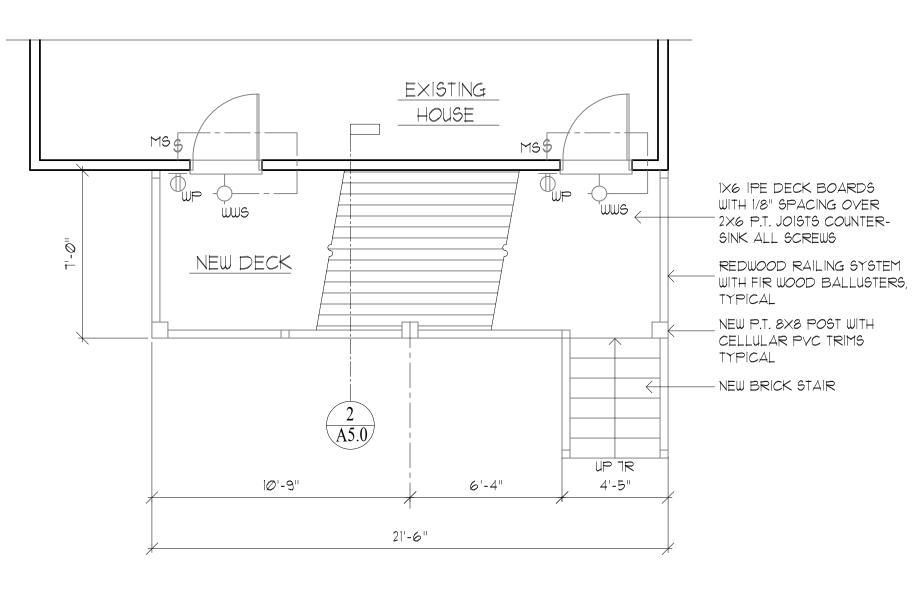

DECK NOTES:

- 1. ALL LUMBER SHALL BE PRESSURE TREATED FOR EXTERIOR USE. ALL METAL FASTENERS AND HANGERS SHALL BE STAINLESS STEEL OR OTHERWISE COMPATIBLE WITH THE WOOD TREATMENT.
- 2. ALL BEAMS, JOISTS AND POSTS SHALL BE No. 2 SOUTHERN PINE OR BETTER.
- 3. ALL BEAM SPLICES AND TOP RAILS SHALL OCCUR AT A POST OR OTHERWISE ON ADEQUATE BEARING.
- WITH FIR WOOD BALLUSTERS, 4. ALL FOOTINGS SHALL BE CAST-IN-PLACE CONCRETE WITH A MINIMUM 3000 PSI COMPRESSIVE STRENGTH AT 28 DAYS.
 - 5. GUARDS ARE REQUIRED AT ALL AREAS WHERE THE DECK FLOOR IS GREATER THAN 30" ABOVE GRADE AT ANY POINT.
 - 6. REQUIRED GUARDS SHALL BE 36" HIGH ABOVE DECK FLOOR AND BE CONSTRUCTED SUCH THAT A 4" DIAMETER OBJECT WILL NOT PASS THROUGH.
 - 7. GUARD POST SPACING SHALL NOT EXCEED 6'-0" ON CENTER.
 - 8. REQUIRED GUARDS AND HANDRAILS AT STAIRS SHALL RANGE FROM 34" TO 38" VERTICAL ABOVE THE STAIR NOSINGS.
 - 9. HANDRAIL ENDS, AT THE TOP AND BOTTOM, SHALL TERMINATE INTO A POST OR BE RETURNED TO WALL.

 $\overline{A1.0}$

- 10. ON STAIRS WITH CLOSED RISERS, TREADS SHALL HAVE A PROJECTED NOSING RANGING FROM 3/4" TO 1 1/4". ALL TREADS AND RISERS SHALL BE EQUAL.
- 11. LIVE LOAD DEFLECTION: JOISTS AND BEAMS L/360, GUARDS L/240
- 12. DESIGN LOADS: FLOOR LIVE LOAD 40 PSI (MIN) WIND SPEED - 90 MPH SOIL BEARING PRESSURE - 3000 PSI.
- 13. GUARDS SHALL BE DESIGNED FOR A 200 LB. CONCENTRATED LOAD PLACED ALONG THE TOP RAIL IN ANY DIRECTION, AT ANY POINT.
- 14. THESE DECKS ARE NOT DESIGNED FOR HOT TUBS OR SPA LOADING.
- 15. EXTERIOR STAIR AND LANDING SHALL BE ILLUMINATED.

BUXTON LLOYD SHIPPY + ASSOCIATES

THE BUILDER SHALL REVIEW ALL DRAWINGS

THOROUGHLY BEFORE COMMENCING WORK

OF MASSACHUSETTS STATE BUILDING CODE.

AND NOTIFY THE DESIGNER OF ANY

DISCREPANCIES WITHING 24" HOURS

2. ALL WORK SHALL MEET REQUIREMENTS


General Notes:

Architectural Designers and Planners

168 Mill Street Winchendon, MA 01475 Tel: 978.297.5033

Richard A. Smith PE Structural Engineer

Reading, MA 01867 Tel: 781.944.4151 email: rasmithPE@verizon.net

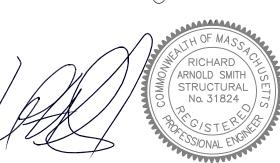

Project For:


ANTHONY SERETAKIS Proposed Rear Decks 197 College Avenue Somerville, MA 02114

Drawing Title:

PROPOSED FIRST, SECOND & THIRD FLOOR DECK PLANS


Job No.		Revision:
Date Issued	10-5-17	
Scale	1/4"=1'-0"	Sheet Number:
Drawn By	BLS	
Approved By	BLS	
Phase: Workin	g Drawings	AI.U

RECEPTACLE OUTLET DUPLEX, 110V, WEATHERPROOF DUPLEX, 110V, WEATHERPROOF SWITCHES SINGLE POLE WITH MOTION SENSOR \$\frac{\frac{1}{3}}{3} \text{MS} \text{SUTCHOS} \text{WITH MOTION SENSOR}

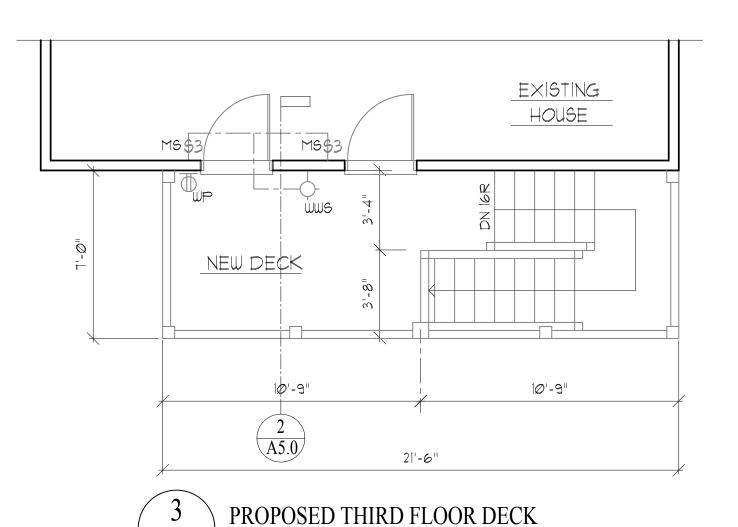




THE BUILDER SHALL COUNTER-SINK ALL SCREWS USED TO SECURE DECKING TO DECK FRAMING

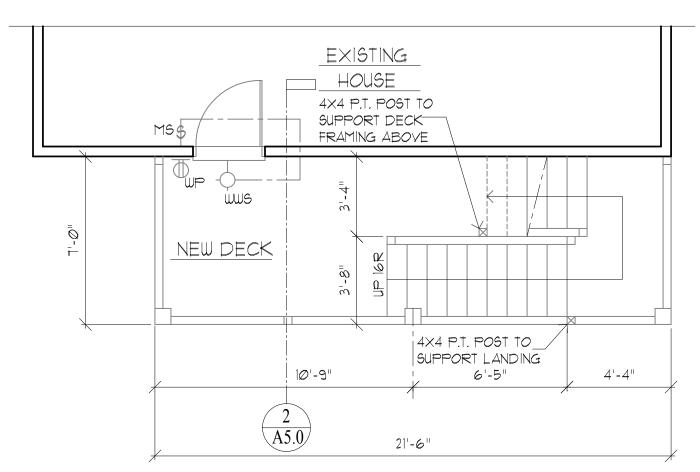

PROPOSED SECOND FLOOR DECK
SCALE: 1/4"=1'-0"

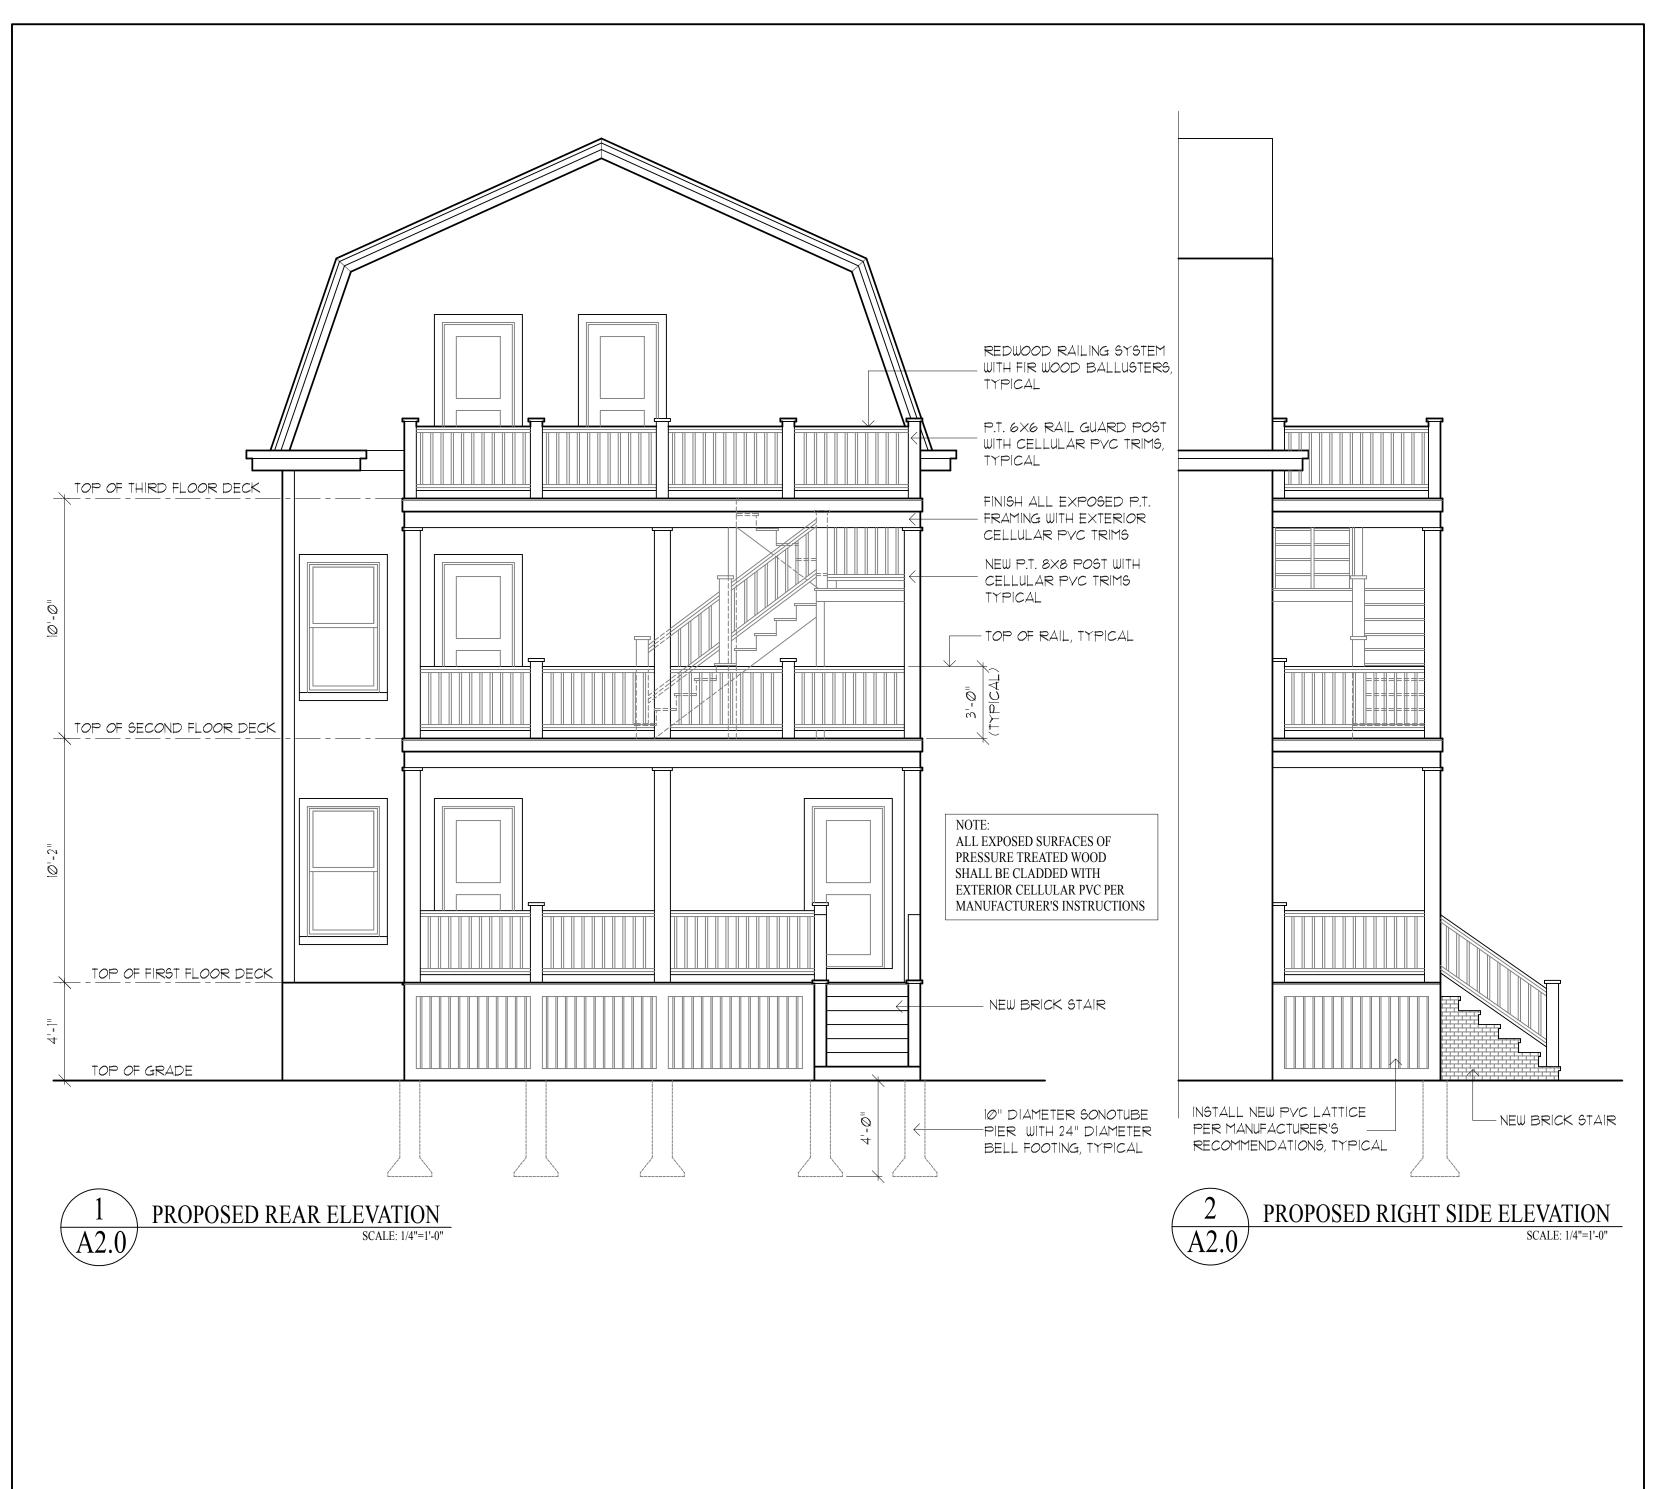

General Notes:

- 1. THE BUILDER SHALL REVIEW ALL DRAWINGS THOROUGHLY BEFORE COMMENCING WORK AND NOTIFY THE DESIGNER OF ANY DISCREPANCIES WITHING 24" HOURS
- 2. ALL WORK SHALL MEET REQUIREMENTS OF MASSACHUSETTS STATE BUILDING CODE.

BUXTON LLOYD SHIPPY + ASSOCIATES

Architectural Designers and Planners

168 Mill Street Winchendon, MA 01475 Tel: 978.297.5033

Richard A. Smith PE Structural Engineer

Reading, MA 01867 Tel: 781.944.4151 email: rasmithPE@verizon.net




Project For:

ANTHONY SERETAKIS Proposed Rear Decks 197 College Avenue Somerville, MA 02114

Drawing Title:

PROPOSED REAR & LEFT SIDE ELEVATIONS

Job No.		Revision:
Date Issued	10-5-17	
Scale	1/4"=1'-0"	Sheet Number:
Drawn By	BLS	
Approved By	BLS	
Phase: Workin	g Drawings	AZ.U

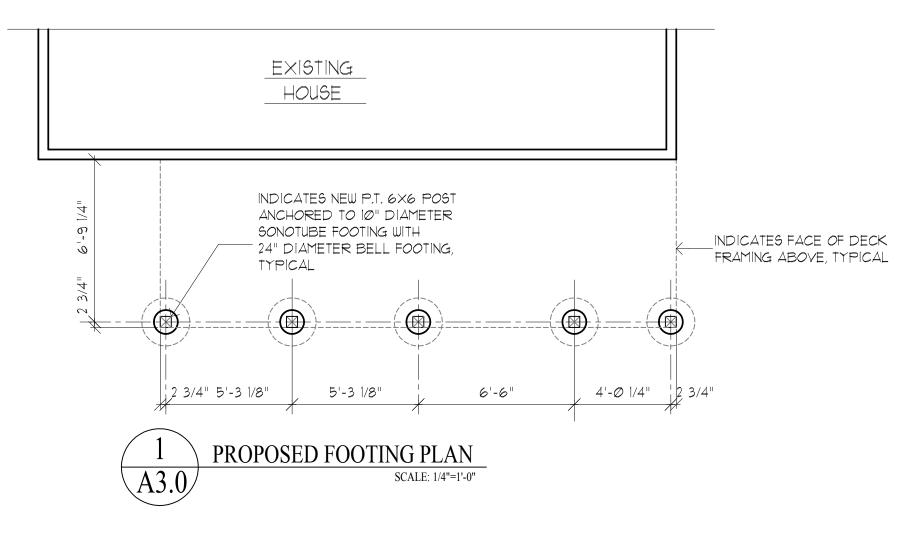

GENERAL STRUCTURAL NOTES

- 1. ALL WORK SHALL CONFORM TO THE REQUIREMENTS OF THE LATEST EDITION OF THE COMMONWEALTH OF MASSACHUSETTS BUILDING CODE (780CMR) AND THE CONTRACT DOCUMENTS. IN CASE OF A CONFLICT, THE MOST STRINGENT REQUIREMENT SHALL GOVERN.
- 2. THE CONTRACTOR MUST HAVE THE EXPERTISE TO EXCUTE ALL WORK INDICATED ON THE DRAWINGS OR SHALL HIRE QUALIFIED HELP.
- 3. ALL REQUESTS FOR CHANGES TO THE STRUCTURAL DRAWINGS FROM CLIENT, THE CONTRACTORS, ETC; OR ANY OTHER CHANGES TO DRAWINGS MADE ON THE SITE MUST BE FOLLOWED UP IN WRITING TO THE STRUCTURAL ENGINEER.
- 4. THE USE OF EXPLOSIVES IS NOT PERMITTED WITHOUT THE WRITTEN PERMISSION OF THE STRUCTURAL ENGINEER.
- 5. THE CONTRACTOR SHALL NOTIFY THE STRUCTURAL ENGINEER, WHEN IN THE COURSE OF CONSTRUCTION OR DEMOLITION, CONDITIONS ARE UNCOVERED WHICH ARE UNANTICIPATED OR OTHERWISE APPEAR TO PRESENT A DANGEROUS CONDITION.
- 6. STRUCTURAL ALTERATION SHALL BE PRECEDED BY ADEQUATE SHORING AND BRACING.

FOUNDATIONS


- 1. FOUNDATIONS SHALL BE CARRIED DOWN TO ELEVATIONS INDICATED ON DRAWINGS OR FURTHER, AS REQUIRED, TO UNDISTURB MATERIAL HAVING A MINIMUM BEARING CAPACITY OF 2 TONS PER SQUARE FOOT.
- 2. FOOTING ELEVATIONS SHOWN ON DRAWINGS REPRESENT ESTIMATED DEPTHS AND ARE NOT TO BE CONSTRUED AS LIMITING THE AMOUNT OF EXCAVATION REQUIRED TO REACH BEARING MATERIAL.
- 3. EXTERIOR CONSTRUCTION SHALL BE CARRIED DOWN BELOW FINISHED EXTERIOR GRADE TO A MINIMUM DEPTH OF 4 FEET UNLESS OTHERWISE NOTED.
- 4. BACKFILL UNDER ANY PORTION OF THE BUILDING SHALL BE COMPACTED IN 6" LIFTS.
- 5. UNLESS OTHERWISE NOTED, FOOTINGS SHALL BE CENTERED UNDER SUPPORTED MEMBERS.
- 6. BACKFILLING SHALL BE DONE SIMULTANEOUSLY ON BOTH SIDES OF THE BUILDING IN ORDER TO MINIMIZE UNBALANCED EARTH PRESSURES.

CONCRETE


1. CONCRETE WORK SHALL CONFORM TO BUILDING CODE REQUIREMENTS FOR REINFORCED CONCRETE (ACI 318) AND SPECIFICATIONS FOR STRUCTURAL CONCRETE FOR BUILDINGS (ACI 301).

NOTE:

ALL CONNECTORS, HARDWARE AND FASTENERS SHALL BE NONCORROSIVE

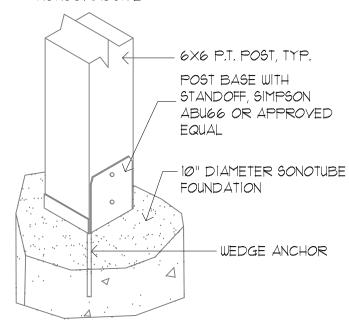

A3.0 DECK POST BASE DETAIL
SCALE: 1"=1'-0"

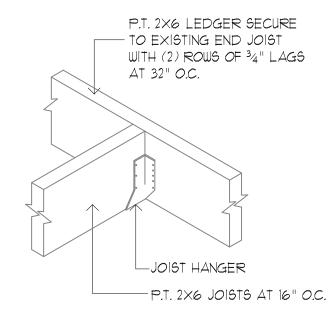



General Notes:

- 1. THE BUILDER SHALL REVIEW ALL DRAWINGS THOROUGHLY BEFORE COMMENCING WORK AND NOTIFY THE DESIGNER OF ANY DISCREPANCIES WITHING 24" HOURS
- 2. ALL WORK SHALL MEET REQUIREMENTS OF MASSACHUSETTS STATE BUILDING CODE.


BUXTON LLOYD SHIPPY + ASSOCIATES

Architectural Designers and Planners

168 Mill Street Winchendon, MA 01475 Tel: 978.297.5033

Richard A. Smith PE Structural Engineer

Reading, MA 01867 Tel: 781.944.4151 email: rasmithPE@verizon.net

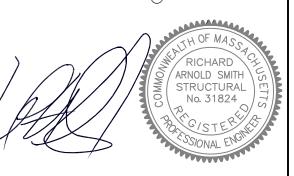


Project For:


ANTHONY SERETAKIS Proposed Rear Decks 197 College Avenue Somerville, MA 02114


Drawing Title:


FOOTING PLAN, FOOTING DETAIL & FRAMING DETAILS

Job No.		Revision:
Date Issued	10-5-17	
Scale	As Noted	Sheet Number:
Drawn By	BLS	
Approved By	BLS	$\mathbf{A} 2 \mathbf{\Lambda}$
Phase: Working Drawings		AJ.U

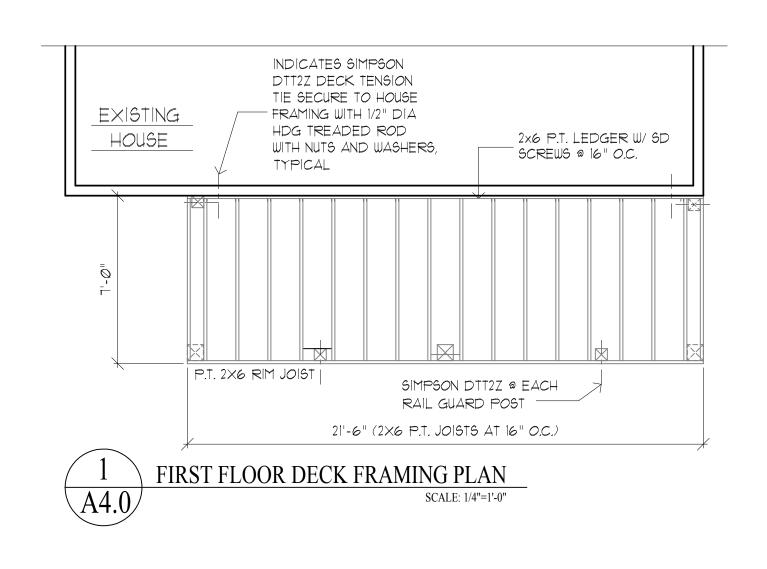

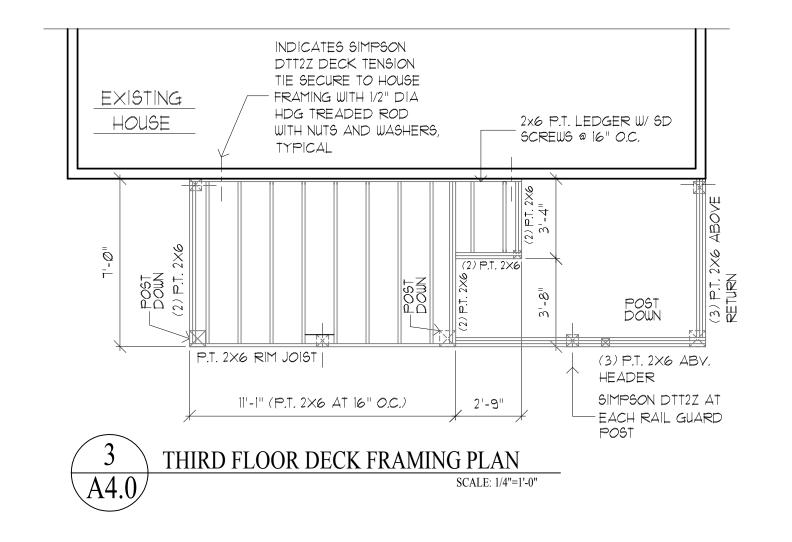

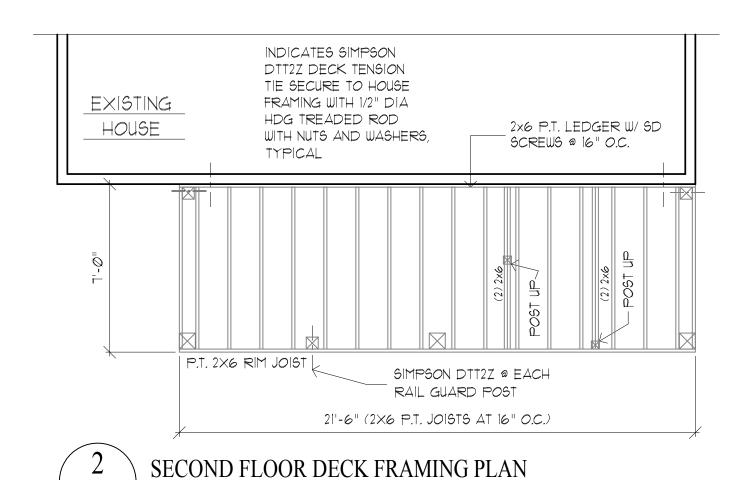

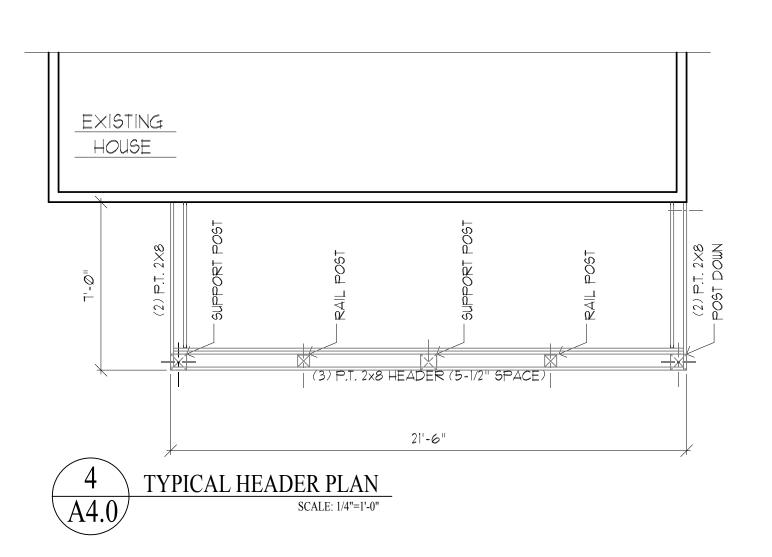

General Notes:

- 1. THE BUILDER SHALL REVIEW ALL DRAWINGS THOROUGHLY BEFORE COMMENCING WORK AND NOTIFY THE DESIGNER OF ANY DISCREPANCIES WITHING 24" HOURS
- 2. ALL WORK SHALL MEET REQUIREMENTS OF MASSACHUSETTS STATE BUILDING CODE.

BUXTON LLOYD SHIPPY + ASSOCIATES

Architectural Designers and Planners

168 Mill Street Winchendon, MA 01475 Tel: 978.297.5033

Richard A. Smith PE Structural Engineer

Reading, MA 01867 Tel: 781.944.4151 email: rasmithPE@verizon.net



Project For:

ANTHONY SERETAKIS Proposed Rear Decks 197 College Avenue Somerville, MA 02114

Drawing Title:

DECK FRAMING PLANS

Job No.		Revision:
Date Issued	10-5-17	
Scale	1/4"=1'-0"	Sheet Number:
Drawn By	BLS	
Approved By	BLS	
Phase: Working Drawings		A4. U